

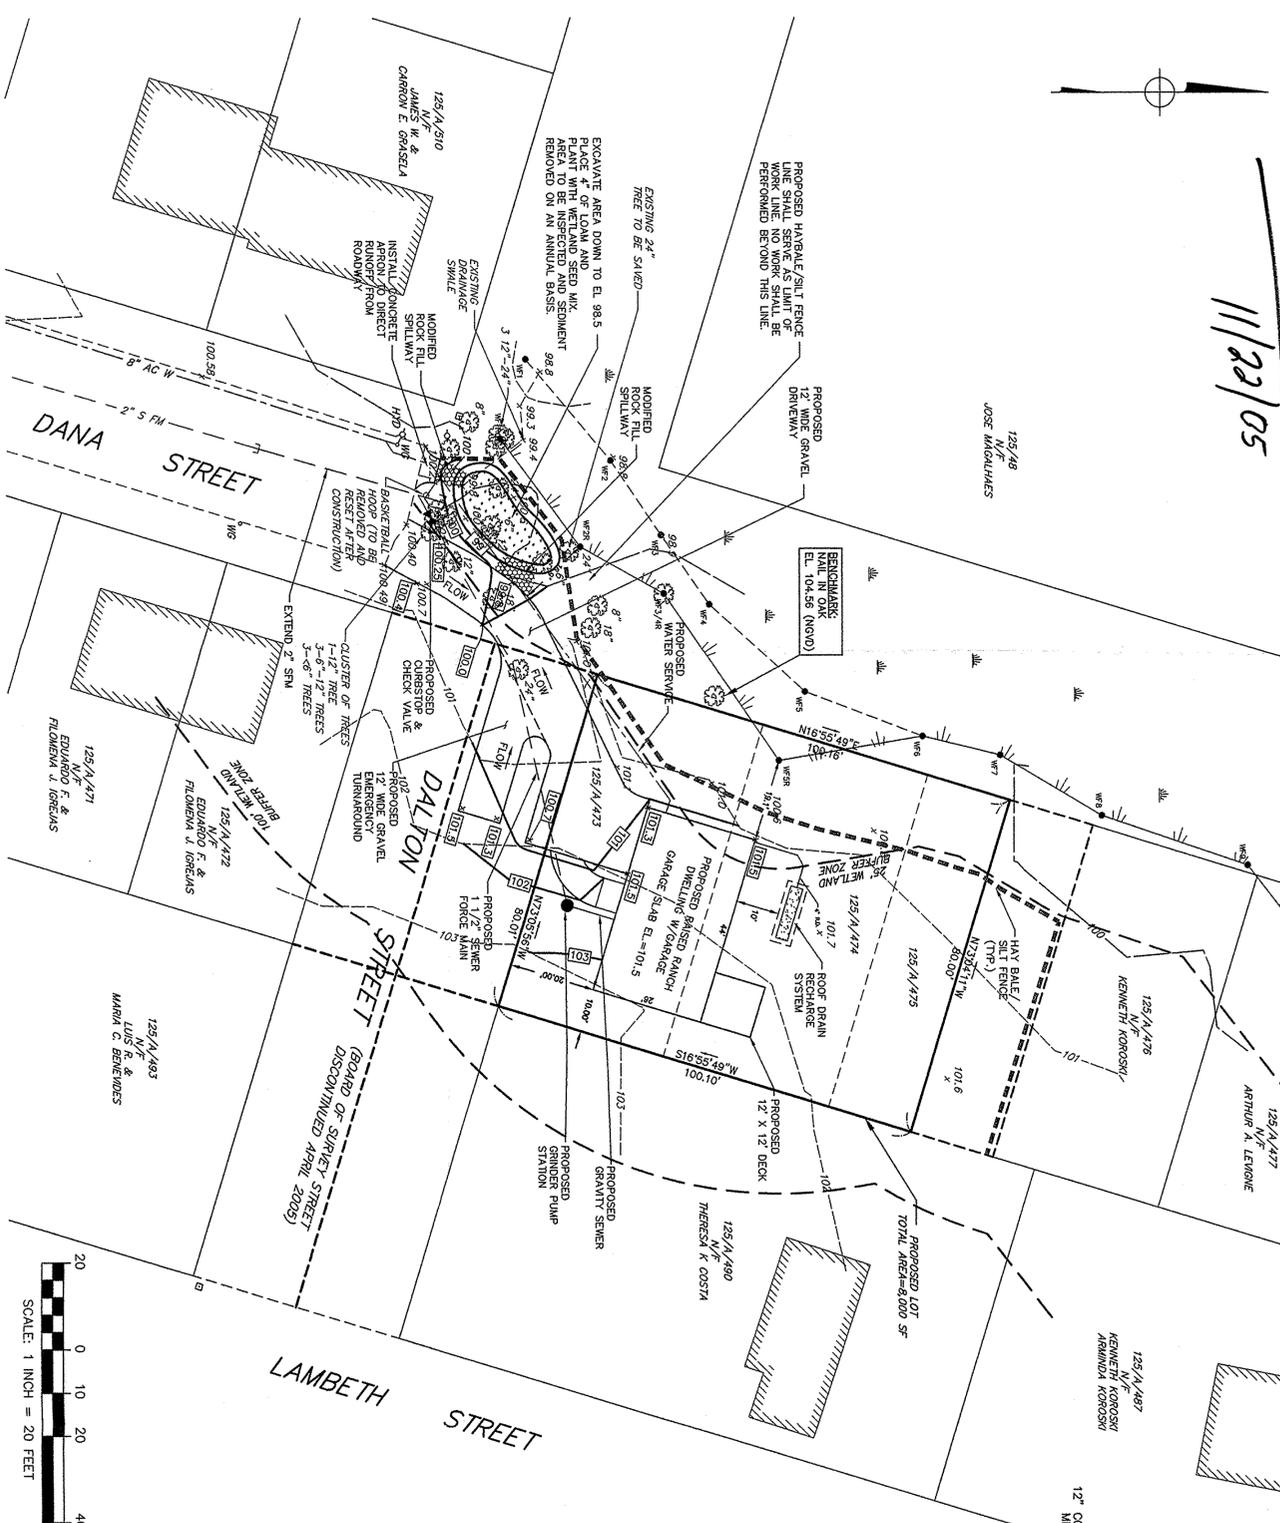
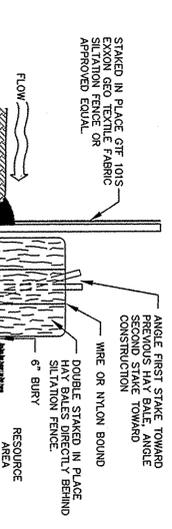




ORIGINAL
PLAN OF RECORD
11/22/05

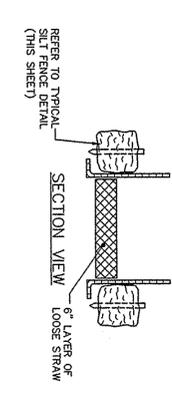


- DEWATERING SPECIFICATIONS**
1. DEWATERING BASINS SHALL BE CONSTRUCTED BEFORE ANY DEWATERING OPERATIONS BEGIN. THE DEWATERING BASINS SHALL BE DIRECTED TO THE NEAREST WETLAND DISCHARGE AREA.
 2. HAY BALES/SILT DEWATERING BASINS SHALL BE CONSTRUCTED BEFORE DEWATERING BEGINS.
 3. ALL SEDIMENT SHALL BE REMOVED AND FINISHED GRADES RESTORED OPERATIONS.

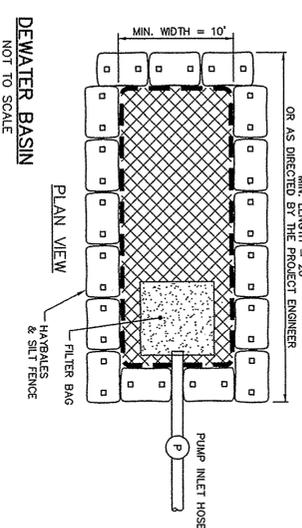


- EROSION CONTROL MEASURES**
1. EROSION CONTROL DEVICES ARE TO BE PLACED PRIOR TO CONSTRUCTION AND ARE TO REMAIN IN PLACE UNTIL ALL CONSTRUCTION IS COMPLETED AND NEW SORES HAVE BEEN STABILIZED.
 2. EROSION CONTROL DEVICES SHALL BE PLACED IN A ROW, ALONG CONTOURS, WITH ENDS TO BE SECURELY ANCHORED IN PLACE BY STAKES OF RE-BARS DRIVEN THROUGH THE DEVICES TO THE SUBSTRATE.
 3. THE EROSION CONTROL DEVICES SHALL BE EMBEDDED IN THE SOIL A MINIMUM OF 6 INCHES.
 4. BALES SHALL BE SECURELY ANCHORED IN PLACE BY STAKES OF RE-BARS DRIVEN THROUGH THE DEVICES TO THE SUBSTRATE.
 5. INSPECTION SHALL BE FREQUENT AND REPAIR OR REPLACEMENT SHALL BE MADE PROMPTLY.
 6. APPROVAL OF EROSION CONTROL DEVICES IS TO BE DONE BY THE CONSERVATION COMMISSION PRIOR TO CONSTRUCTION.

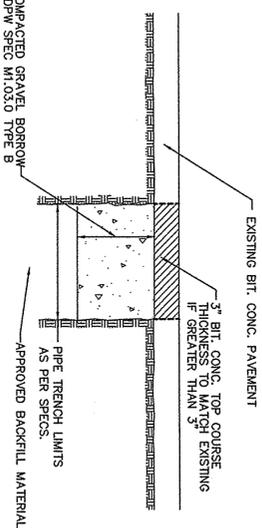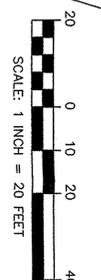


PAVEMENT RESTORATION
NOT TO SCALE

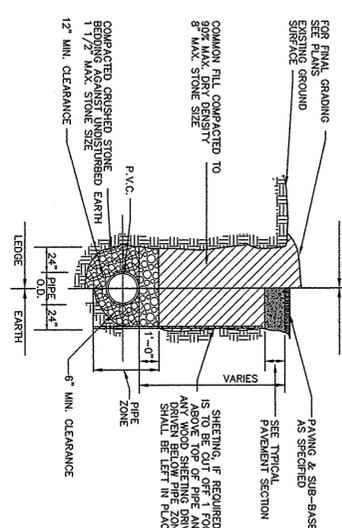

GRAVITY SEWER/FORCE MAIN TRENCH DETAIL
NOT TO SCALE

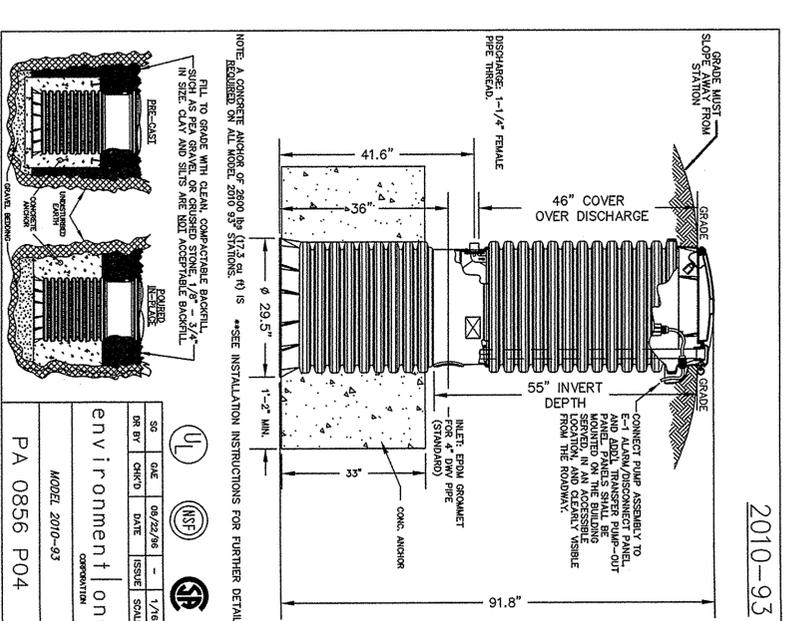

NO	REV	DATE	ISSUE	SCALE
01	01	08/22/98	ISSUE	1/16"
02	01	08/22/98	ISSUE	1/16"

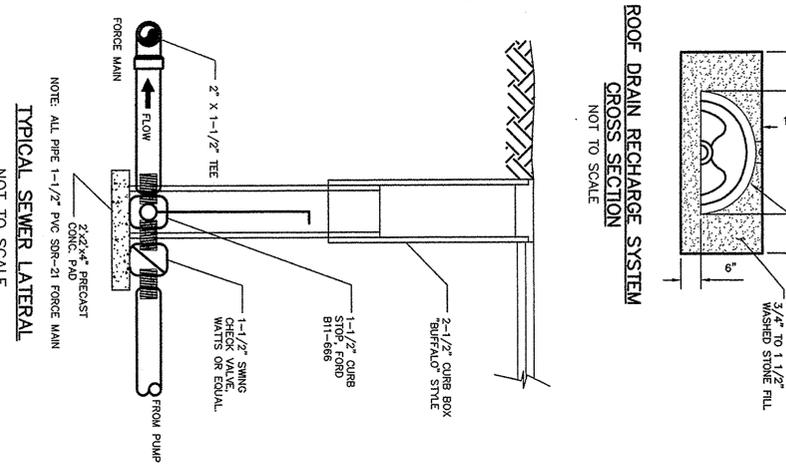

ROOF DRAIN RECHARGE SYSTEM
NOT TO SCALE

TYPICAL SEWER LATERAL
NOT TO SCALE

- GENERAL CONSTRUCTION NOTES**
1. THE MATERIALS AND CONSTRUCTION OF ALL THE PROPOSED UTILITIES SHALL CONFORM TO THE LOCAL D.P.W. STANDARDS AND SPECIFICATIONS AS WELL AS ALL APPLICABLE MASS. D.P.W. STANDARDS AND SPECIFICATIONS, LATEST EDITION.
 2. ALL CONSTRUCTION MATERIALS, SUCH AS ALL MATERIAL, SOLE PLACEMENT, AND MANUFACTURERS DATA, LOCATION AND INSTALLATION.
 3. THE LOCATION AND ELEVATION OF ALL EXISTING UTILITIES SHALL BE CONSIDERED APPROXIMATE AND NOT GUARANTEED. THE CONTRACTOR SHALL VERIFY THE LOCATION AND ELEVATION OF ALL EXISTING UTILITIES AND THE BEST AVAILABLE RECORD INFORMATION AND ARE NOT TO BE USED FOR CONSTRUCTION. THE CONTRACTOR SHALL BE RESPONSIBLE FOR VERIFYING THE LOCATION AND ELEVATION OF ALL EXISTING UTILITIES.
 4. THE CONTRACTOR SHALL CONTACT THE UTILITY COMPANIES OF ANY EXCAVATION AND/OR SURFACE TESTING TO INFORM THE UTILITY COMPANIES OF ANY EXCAVATION.
 5. EXCEPT WHERE NOTED, WHENEVER EXISTING UTILITIES ARE ENCOUNTERED, THE CONTRACTOR SHALL REPAIR OR REPLACE THEM TO ORIGINAL OR BETTER CONDITION. THE CONTRACTOR SHALL BE RESPONSIBLE FOR REPAIRING OR REPLACING THEM TO ORIGINAL OR BETTER CONDITION.
 6. ALL EXCAVATED MATERIAL DESIGNATED FOR REUSE SHALL BE STOCKPILED ON SITE NO HIGHER THAN 8 FEET AND SHALL BE COVERED BY TEMPORARY SILT FENCES TO PREVENT TRAVEL OF SEDIMENT TO ADJACENT AREAS.
 7. LOCATION, STORAGE, AND WASTE MATERIAL ON SITE WILL NOT BE PERMITTED.
 8. EROSION CONTROL MEASURES SHALL REMAIN IN PLACE AND MAINTAINED IN GOOD CONDITION UNTIL SURFACE RESTORATION IS COMPLETE AND ALL AREAS DISTURBED BY THE CONTRACTOR'S OPERATIONS ARE STABILIZED.
 9. THE CONTRACTOR SHALL PROTECT ADJACENT PROPERTIES FROM ON-SITE CONSTRUCTION ACTIVITIES AND SHALL BE RESPONSIBLE FOR THE PROTECTION OF ADJACENT PROPERTIES.
 10. DRAINAGE GENERATED AS A RESULT OF TRENCH DEWATERING SHALL BE DISCHARGED TO EXISTING DRAINAGE SYSTEMS WITH PROPER EROSION CONTROL, AND DEWATERING MEASURES SUBJECT TO APPROVAL BY THE PROJECT ENGINEER. UNLESS OTHERWISE NOTED, ALL DRAINAGE SHALL BE DISCHARGED TO EXISTING DRAINAGE SYSTEMS.
 11. THE OWNER AND THE PROJECT ENGINEER SHALL APPROVE ALL FIELD CHANGES IN THE WORK PRIOR TO IMPLEMENTATION. NO FIELD CHANGES SHALL BE MADE IN ANY SPECIFIED SITE WORK OR ANY MATERIALS FOR WHICH THE CONTRACTOR IS RESPONSIBLE WITHOUT THE WRITTEN APPROVAL OF THE OWNER AND THE PROJECT ENGINEER. ANY CHANGES TO THE WORK SHALL BE MADE WITHOUT THE WRITTEN APPROVAL OF THE OWNER AND THE PROJECT ENGINEER.
 12. ALL WORK SHALL BE COMPLETED WITHIN THE SPECIFIED TIME FRAME AND SPECIFICATIONS OF THE LOCAL DEPT. OF PUBLIC WORKS SHALL BE IMMEDIATELY REMOVED AND REPLACED AT THE FULL RESPONSIBILITY AND COST/EXPENSE TO THE CONTRACTOR.
 13. THE CONTRACTOR SHALL BE RESPONSIBLE FOR ALL SITE PREPARATION, THE CONSTRUCTION AND ALL NECESSARY STAKING, BRACING AND TRENCH DEWATERING FOR THE COMPLETE INSTALLATION OF THE PROJECT FACILITIES DURING CONSTRUCTION.
 14. ALL OPEN EXCAVATIONS SHALL BE REROUTED/REWORKED IN STRICT ACCORDANCE WITH LOCAL D.P.W. STANDARDS AND SPECIFICATIONS. THE CONTRACTOR SHALL BE RESPONSIBLE FOR THE PROTECTION OF ADJACENT PROPERTIES AND SHALL BE RESPONSIBLE FOR THE PROTECTION OF ADJACENT PROPERTIES.
 15. THESE PLANS HAVE BEEN PREPARED SPECIFICALLY AS SUPPLEMENTAL INFORMATION TO ACCOMPANY THE PERMIT APPLICATIONS AND ARE NOT INTENDED FOR ACTUAL CONSTRUCTION WITHOUT THE APPROVAL OF THE PROJECT ENGINEER.
 16. ALL SLOPES SHALL BE GRADED AT NO LESS THAN 3:1, LAND DISTURBING ACTIVITIES WITHIN ANY EXCAVATION SHALL BE COMPLETED WITHIN THE SPECIFIED TIME FRAME AND SPECIFICATIONS.
 17. CONTRACTOR SHALL FIELD VERIFY THE HORIZONTAL AND VERTICAL LOCATION OF EXISTING UTILITIES AND REPORT FINDINGS TO THE PROJECT ENGINEER.
 18. IN THE EVENT OF AN INCONSISTENCY BETWEEN THESE SPECIFICATIONS AND THE LOCAL D.P.W., THE LOCAL D.P.W. SPECIFICATIONS SHALL PREVAIL. THE CONTRACTOR SHALL OBTAIN ALL APPLICABLE RECORD INFORMATION AND VERIFY THE LOCATION AND ELEVATION OF ALL EXISTING UTILITIES.
 19. PROPOSED USE OF EXISTING UTILITIES AND EXISTING CONDITIONS SHOWN ARE BASED ON AN ACTUAL FIELD SURVEY CONDUCTED BY THE PROJECT ENGINEER ON JULY 2004.
 20. THE WORK SHOWN ON THIS DRAWING IS SUBJECT TO A CHANGE OF INTEREST WITH THE CITY OF NEW BEDFORD. THE CONTRACTOR SHALL OBTAIN ALL NECESSARY PERMITS FROM THE CITY OF NEW BEDFORD.
 21. FORCE MAIN TO BE PRESSURE TESTED WITH AIR. LINE IS TO HOLD 65 PSI FOR A MINIMUM OF ONE HOUR.
 22. INSTALLATION AND MAINTENANCE OF THE PUMP STATION AND FORCE MAIN ARE THE RESPONSIBILITY OF THE CONTRACTOR.
 23. ALL WORK IN PUBLIC WAYS SHALL BE PERFORMED BY A CONTRACTOR REGISTERED WITH THE CITY OF NEW BEDFORD AS A DESIGNATED BIDDING FIRM.



PERMITTING

Scale	1"=20'
Drawn by	RRR
Designed by	RRR
Checked by	RRR
Issued For	
Date	5/12/05

No.	Description	Date	By/For
1	REVISION PER CLIENT REVIEW	7/21/05	RRR
2	REVISION PER CLIENT REVIEW	7/21/05	RRR
3	REVISION PER CLIENT REVIEW	8/20/05	RRR
4	REVISION PER CLIENT REVIEW	11/7/05	RRR
5	REVISION PER CLIENT REVIEW	11/7/05	RRR
6	SHOWN EXISTING TRENCH	11/22/05	RRR

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CONSULTING ENGINEERS

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14 TAUNTON, MA 02729
TEL: (508) 824-9279
FAX: (508) 824-9276

SITE PLAN
KENNETH KOROSKI

DANA STREET
NEW BEDFORD, MASSACHUSETTS

SITE PLAN

Project No. 1266
Sheet 1 OF 1

